

617.20  
Appendix A  
State Environmental Quality Review  
FULL ENVIRONMENTAL ASSESSMENT FORM

Purpose: The full EAF is designed to help applicants and agencies determine, in an orderly manner, whether a project or action may be significant. The question of whether an action may be significant is not always easy to answer. Frequently, there are aspects of a project that are subjective or unmeasurable. It is also understood that those who determine significance may have little or no formal knowledge of the environment or may not be technically expert in environmental analysis. In addition, many who have knowledge in one particular area may not be aware of the broader concerns affecting the question of significance.

The full EAF is intended to provide a method whereby applicants and agencies can be assured that the determination process has been orderly, comprehensive in nature, yet flexible enough to allow introduction of information to fit a project or action.

Full EAF Components: The full EAF is comprised of three parts:

- Part 1: Provides objective data and information about a given project and its site. By identifying basic project data, it assists a reviewer in the analysis that takes place in Parts 2 and 3.
- Part 2: Focuses on identifying the range of possible impacts that may occur from a project or action. It provides guidance as to whether an impact is likely to be considered small to moderate or whether it is a potentially-large impact. The form also identifies whether an impact can be mitigated or reduced.
- Part 3: If any impact in Part 2 is identified as potentially-large, then Part 3 is used to evaluate whether or not the impact is actually important.

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**THIS AREA FOR LEAD AGENCY USE ONLY**

**DETERMINATION OF SIGNIFICANCE -- Type 1 and Unlisted Actions**

Identify the Portions of EAF completed for this project:       Part 1                       Part 2                       Part 3  
Upon review of the information recorded on this EAF (Parts 1 and 2 and 3 if appropriate), and any other supporting information, and considering both the magnitude and importance of each impact, it is reasonably determined by the lead agency that:

- A. The project will not result in any large and important impact(s) and, therefore, is one which will not have a significant impact on the environment, therefore a negative declaration will be prepared.
- B. Although the project could have a significant effect on the environment, there will not be a significant effect for this Unlisted Action because the mitigation measures described in PART 3 have been required, therefore a CONDITIONED negative declaration will be prepared.\*
- C. The project may result in one or more large and important impacts that may have a significant impact on the environment, therefore a positive declaration will be prepared.

\*A Conditioned Negative Declaration is only valid for Unlisted Actions

Montante Residence and Barn Demolition, 4805 Shimerville Road

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Name of Action

Clarence Planning Board

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Name of Lead Agency

Brad Packard

Assistant Director of Community Development

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Print or Type Name of Responsible Officer in Lead Agency

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Title of Responsible Officer

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Signature of Responsible Officer in Lead Agency

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Signature of Preparer (If different from responsible officer)

April 2012

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Date

PART 1--PROJECT INFORMATION

Prepared by Project Sponsor

NOTICE: This document is designed to assist in determining whether the action proposed may have a significant effect on the environment. Please complete the entire form, Parts A through E. Answers to these questions will be considered as part of the application for approval and may be subject to further verification and public review. Provide any additional information you believe will be needed to complete Parts 2 and 3.

It is expected that completion of the full EAF will be dependent on information currently available and will not involve new studies, research or investigation. If information requiring such additional work is unavailable, so indicate and specify each instance.

Name of Action Montante Residence and Barn Demolition, 4805 Shimerville Road

Location of Action (include Street Address, Municipality and County)

4805 Shimerville Road  
Clarence, NY 14031 (Erie County)

Name of Applicant/Sponsor Uniland Development Corporation

Address 100 Corporate Parkway, Suite 500

City / PO Amherst State NY Zip Code 14226

Business Telephone (716) 834-5000

Name of Owner (if different) Carol Montante

Address \_\_\_\_\_

City / PO \_\_\_\_\_ State \_\_\_\_\_ Zip Code \_\_\_\_\_

Business Telephone \_\_\_\_\_

Description of Action:

Demolition of a residence and barn at the property located at 4805 Shimerville Road. Both structures were built prior to 1950.

Please Complete Each Question--Indicate N.A. if not applicable

**A. SITE DESCRIPTION**

Physical setting of overall project, both developed and undeveloped areas.

1. Present Land Use:  Urban     Industrial     Commercial     Residential (suburban)     Rural (non-farm)  
 Forest     Agriculture     Other \_\_\_\_\_  
 \_\_\_\_\_  
 \_\_\_\_\_

2. Total acreage of project area: 1.4 acres.

APPROXIMATE ACREAGE	PRESENTLY	AFTER COMPLETION
Meadow or Brushland (Non-agricultural)	<u>1.2</u> acres	<u>1.3</u> acres
Forested	_____ acres	_____ acres
Agricultural (Includes orchards, cropland, pasture, etc.)	_____ acres	_____ acres
Wetland (Freshwater or tidal as per Articles 24,25 of ECL)	_____ acres	_____ acres
Water Surface Area	_____ acres	_____ acres
Unvegetated (Rock, earth or fill)	_____ acres	_____ acres
Roads, buildings and other paved surfaces	<u>.2</u> acres	<u>.1</u> acres
Other (Indicate type) _____	_____ acres	_____ acres

3. What is predominant soil type(s) on project site? Cazenovia Silt Loam

- a. Soil drainage:  Well drained 100 % of site     Moderately well drained \_\_\_\_\_ % of site.  
 Poorly drained \_\_\_\_\_ % of site

b. If any agricultural land is involved, how many acres of soil are classified within soil group 1 through 4 of the NYS Land Classification System? 0 acres (see 1 NYCRR 370).

4. Are there bedrock outcroppings on project site?  Yes     No

a. What is depth to bedrock >5' (in feet)

5. Approximate percentage of proposed project site with slopes:

- 0-10% \_\_\_\_\_ %     10- 15% \_\_\_\_\_ %     15% or greater \_\_\_\_\_ %

6. Is project substantially contiguous to, or contain a building, site, or district, listed on the State or National Registers of Historic Places?  Yes     No

7. Is project substantially contiguous to a site listed on the Register of National Natural Landmarks?  Yes     No

8. What is the depth of the water table? >5' (in feet)

9. Is site located over a primary, principal, or sole source aquifer?  Yes     No

10. Do hunting, fishing or shell fishing opportunities presently exist in the project area?  Yes     No

11. Does project site contain any species of plant or animal life that is identified as threatened or endangered?  Yes  No

According to:

NYSDEC

Identify each species:

12. Are there any unique or unusual land forms on the project site? (i.e., cliffs, dunes, other geological formations?)

Yes  No

Describe:

13. Is the project site presently used by the community or neighborhood as an open space or recreation area?

Yes  No

If yes, explain:

14. Does the present site include scenic views known to be important to the community?  Yes  No

15. Streams within or contiguous to project area:

N/A

a. Name of Stream and name of River to which it is tributary

16. Lakes, ponds, wetland areas within or contiguous to project area:

N/A

b. Size (in acres):

17. Is the site served by existing public utilities?  Yes  No
- a. If YES, does sufficient capacity exist to allow connection?  Yes  No
- b. If YES, will improvements be necessary to allow connection?  Yes  No
18. Is the site located in an agricultural district certified pursuant to Agriculture and Markets Law, Article 25-AA, Section 303 and 304?  Yes  No
19. Is the site located in or substantially contiguous to a Critical Environmental Area designated pursuant to Article 8 of the ECL, and 6 NYCRR 617?  Yes  No
20. Has the site ever been used for the disposal of solid or hazardous wastes?  Yes  No

B. Project Description

1. Physical dimensions and scale of project (fill in dimensions as appropriate).
- a. Total contiguous acreage owned or controlled by project sponsor: N/A acres.
- b. Project acreage to be developed: \_\_\_\_\_ acres initially; \_\_\_\_\_ acres ultimately.
- c. Project acreage to remain undeveloped: \_\_\_\_\_ acres.
- d. Length of project, in miles: N/A (if appropriate)
- e. If the project is an expansion, indicate percent of expansion proposed. N/A %
- f. Number of off-street parking spaces existing \_\_\_\_\_; proposed \_\_\_\_\_
- g. Maximum vehicular trips generated per hour: \_\_\_\_\_ (upon completion of project)?
- h. If residential: Number and type of housing units:
- |            | One Family | Two Family | Multiple Family | Condominium |
|------------|------------|------------|-----------------|-------------|
| Initially  | _____      | _____      | _____           | _____       |
| Ultimately | _____      | _____      | _____           | _____       |
- i. Dimensions (in feet) of largest proposed structure: \_\_\_\_\_ height; \_\_\_\_\_ width; \_\_\_\_\_ length.
- j. Linear feet of frontage along a public thoroughfare project will occupy is? \_\_\_\_\_ ft.
2. How much natural material (i.e. rock, earth, etc.) will be removed from the site? N/A tons/cubic yards.
3. Will disturbed areas be reclaimed  Yes  No  N/A
- a. If yes, for what intended purpose is the site being reclaimed?
- Restoration of the excavated basement foundation.
- b. Will topsoil be stockpiled for reclamation?  Yes  No
- c. Will upper subsoil be stockpiled for reclamation?  Yes  No
4. How many acres of vegetation (trees, shrubs, ground covers) will be removed from site? N/A acres.

5. Will any mature forest (over 100 years old) or other locally-important vegetation be removed by this project?

Yes  No

6. If single phase project: Anticipated period of construction: \_\_\_\_\_ months, (including demolition)

7. If multi-phased:

a. Total number of phases anticipated \_\_\_\_\_ (number)

b. Anticipated date of commencement phase 1: \_\_\_\_\_ month \_\_\_\_\_ year, (including demolition)

c. Approximate completion date of final phase: \_\_\_\_\_ month \_\_\_\_\_ year.

d. Is phase 1 functionally dependent on subsequent phases?  Yes  No

8. Will blasting occur during construction?  Yes  No

9. Number of jobs generated: during construction \_\_\_\_\_; after project is complete \_\_\_\_\_

10. Number of jobs eliminated by this project \_\_\_\_\_.

11. Will project require relocation of any projects or facilities?  Yes  No

If yes, explain:

12. Is surface liquid waste disposal involved?  Yes  No

a. If yes, indicate type of waste (sewage, industrial, etc) and amount \_\_\_\_\_

b. Name of water body into which effluent will be discharged \_\_\_\_\_

13. Is subsurface liquid waste disposal involved?  Yes  No Type \_\_\_\_\_

14. Will surface area of an existing water body increase or decrease by proposal?  Yes  No

If yes, explain:

15. Is project or any portion of project located in a 100 year flood plain?  Yes  No

16. Will the project generate solid waste?  Yes  No

a. If yes, what is the amount per month? \_\_\_\_\_ tons

b. If yes, will an existing solid waste facility be used?  Yes  No

c. If yes, give name \_\_\_\_\_; location \_\_\_\_\_

d. Will any wastes not go into a sewage disposal system or into a sanitary landfill?  Yes  No

e. If yes, explain:

17. Will the project involve the disposal of solid waste?  Yes  No

a. If yes, what is the anticipated rate of disposal? \_\_\_\_\_ tons/month.

b. If yes, what is the anticipated site life? \_\_\_\_\_ years.

18. Will project use herbicides or pesticides?  Yes  No

19. Will project routinely produce odors (more than one hour per day)?  Yes  No

20. Will project produce operating noise exceeding the local ambient noise levels?  Yes  No

21. Will project result in an increase in energy use?  Yes  No

If yes, indicate type(s)

22. If water supply is from wells, indicate pumping capacity \_\_\_\_\_ gallons/minute.

23. Total anticipated water usage per day \_\_\_\_\_ gallons/day.

24. Does project involve Local, State or Federal funding?  Yes  No

If yes, explain:

25. Approvals Required:

			Type	Submittal Date
City, Town, Village Board	<input checked="" type="checkbox"/> Yes	<input type="checkbox"/> No	SEQR Determination	5/2012
City, Town, Village Planning Board	<input type="checkbox"/> Yes	<input type="checkbox"/> No		
City, Town Zoning Board	<input type="checkbox"/> Yes	<input type="checkbox"/> No		
City, County Health Department	<input type="checkbox"/> Yes	<input type="checkbox"/> No		
Other Local Agencies	<input type="checkbox"/> Yes	<input type="checkbox"/> No		
Other Regional Agencies	<input type="checkbox"/> Yes	<input type="checkbox"/> No		
State Agencies	<input type="checkbox"/> Yes	<input type="checkbox"/> No		
Federal Agencies	<input type="checkbox"/> Yes	<input type="checkbox"/> No		

C. Zoning and Planning Information

1. Does proposed action involve a planning or zoning decision?  Yes  No

If Yes, indicate decision required:

- |   |   |  |                                      |
|---|---|--|--------------------------------------|
| <input type="checkbox"/> Zoning amendment | <input type="checkbox"/> Zoning variance    | <input type="checkbox"/> New/revision of master plan | <input type="checkbox"/> Subdivision |
| <input type="checkbox"/> Site plan        | <input type="checkbox"/> Special use permit | <input type="checkbox"/> Resource management plan    | <input type="checkbox"/> Other       |

2. What is the zoning classification(s) of the site?

Residential Single Family

3. What is the maximum potential development of the site if developed as permitted by the present zoning?

Same as current zoning (1 single family residence)

4. What is the proposed zoning of the site?

same

5. What is the maximum potential development of the site if developed as permitted by the proposed zoning?

same

6. Is the proposed action consistent with the recommended uses in adopted local land use plans?  Yes  No

7. What are the predominant land use(s) and zoning classifications within a ¼ mile radius of proposed action?

Residential

8. Is the proposed action compatible with adjoining/surrounding land uses with a ¼ mile?  Yes  No

9. If the proposed action is the subdivision of land, how many lots are proposed? N/A

a. What is the minimum lot size proposed? \_\_\_\_\_

10. Will proposed action require any authorization(s) for the formation of sewer or water districts?  Yes  No

11. Will the proposed action create a demand for any community provided services (recreation, education, police, fire protection)?

Yes  No

a. If yes, is existing capacity sufficient to handle projected demand?  Yes  No

12. Will the proposed action result in the generation of traffic significantly above present levels?  Yes  No

a. If yes, is the existing road network adequate to handle the additional traffic.  Yes  No

D. Informational Details

Attach any additional information as may be needed to clarify your project. If there are or may be any adverse impacts associated with your proposal, please discuss such impacts and the measures which you propose to mitigate or avoid them.

E. Verification

I certify that the information provided above is true to the best of my knowledge.

Applicant/Sponsor Name Clarence Planning Board Date 5/2012

Signature \_\_\_\_\_

Title Assistant Director of Community Development

If the action is in the Coastal Area, and you are a state agency, complete the Coastal Assessment Form before proceeding with this assessment.



**SITE DATA**

PROJECT ACREAGE: 422.6± acres  
 EXISTING ZONING: R-SF, A-RR  
 UTILIZES THE OPEN SPACE DESIGN DEVELOPMENT  
 SINGLE FAMILY HOMES: 288  
 PATIO HOMES: 101  
 QUADPLEX UNITS: 68  
 TOTAL NUMBER OF UNITS PROPOSED: 457±

REQUIRED OPEN SPACE (50%): 211.3± acres  
 PROPOSED OPEN SPACE: 211.3± acres

 OPEN SPACE/CONSERVATION AREA

 ADDITIONAL PROPERTY ADDED

Town of Clarence  
 ERIE COUNTY NEW YORK  
 TOWN JOB NO.:

APPROVED BY: \_\_\_\_\_ DATE: \_\_\_\_\_

TOWN ENGINEER: \_\_\_\_\_ DATE: \_\_\_\_\_

REVISION: \_\_\_\_\_ DATE: \_\_\_\_\_ BY: \_\_\_\_\_

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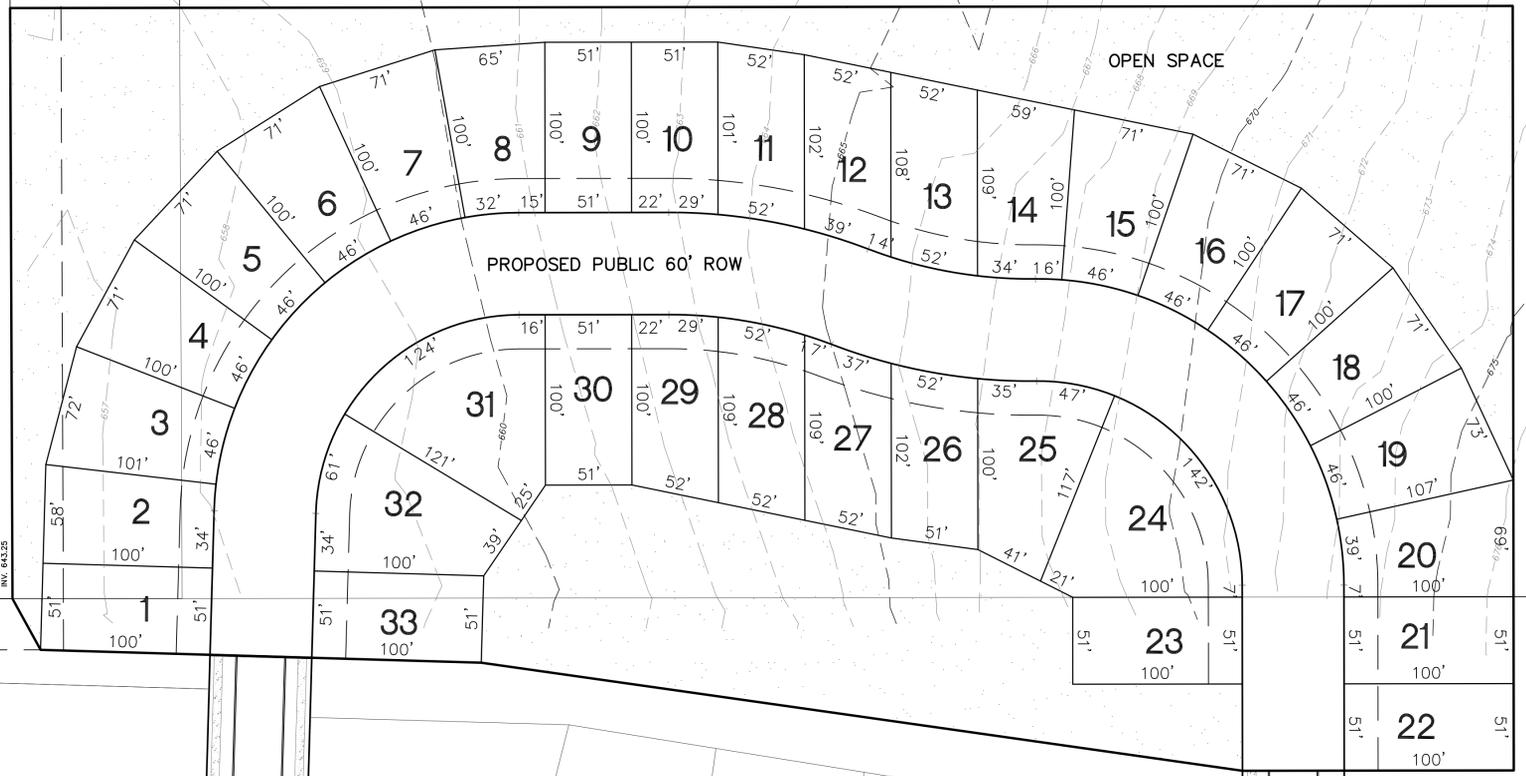
**SPAULDING GREEN**

OVERALL CONCEPT PLAN-EXPANSION

**GPI** GREENMAN-FEDERSEN, INC.  
 CONSULTING ENGINEERS  
 ENGINEERING - SURVEYING - PLANNING  
 400 BRIDGE STREET SUITE 105 BUFFALO, NY 14202  
 (716) 833-4944 FAX: (716) 833-8866

JOB NO.: 2007086  
 DATE: OCTOBER 2011  
 SCALE: 1" = 200'

SHEET NO.: 1 of 1



### Site Data

Present Zoning: R-SF (Residential Single Family)  
 Proposed utilizing the Open Space Overlay District  
 Lots:

- Number shown: 33
- Minimum lot width at setback: 50'
- Minimum lot area shown: 5,000± sq.ft.
- Site Area: 8.35± acres

**Town of Clarence**  
 ERIE COUNTY NEW YORK

TOWN JOB NO.: \_\_\_\_\_

APPROVED BY: \_\_\_\_\_

TOWN ENGINEER \_\_\_\_\_ DATE: \_\_\_\_\_

REVISION	DATE	BY

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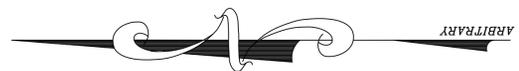
**SPAULDING GREEN  
 EXPANSION - PHASE 11**

CONCEPT PLAN



**GPI**  
**GREENMAN-FEDERSEN, INC.**  
 CONSULTING ENGINEERS

ENGINEERING • SURVEYING • PLANNING  
 SURVEYING SERVICES PERFORMED BY GFI ENGINEERING AND SURVEYING LLP  
 4950 GENESEE STREET SUITE 165 BUFFALO, NY 14225  
 (716) 633-4844 FAX (716) 633-4842

DRAWN: _____	JOB NO.: 2007086	SHEET NO.:
CHECKED: _____	DATE: APRIL 2012	
APPROVED: _____	SCALE: 1" = 50'	



CLARENCE CENTER ROAD

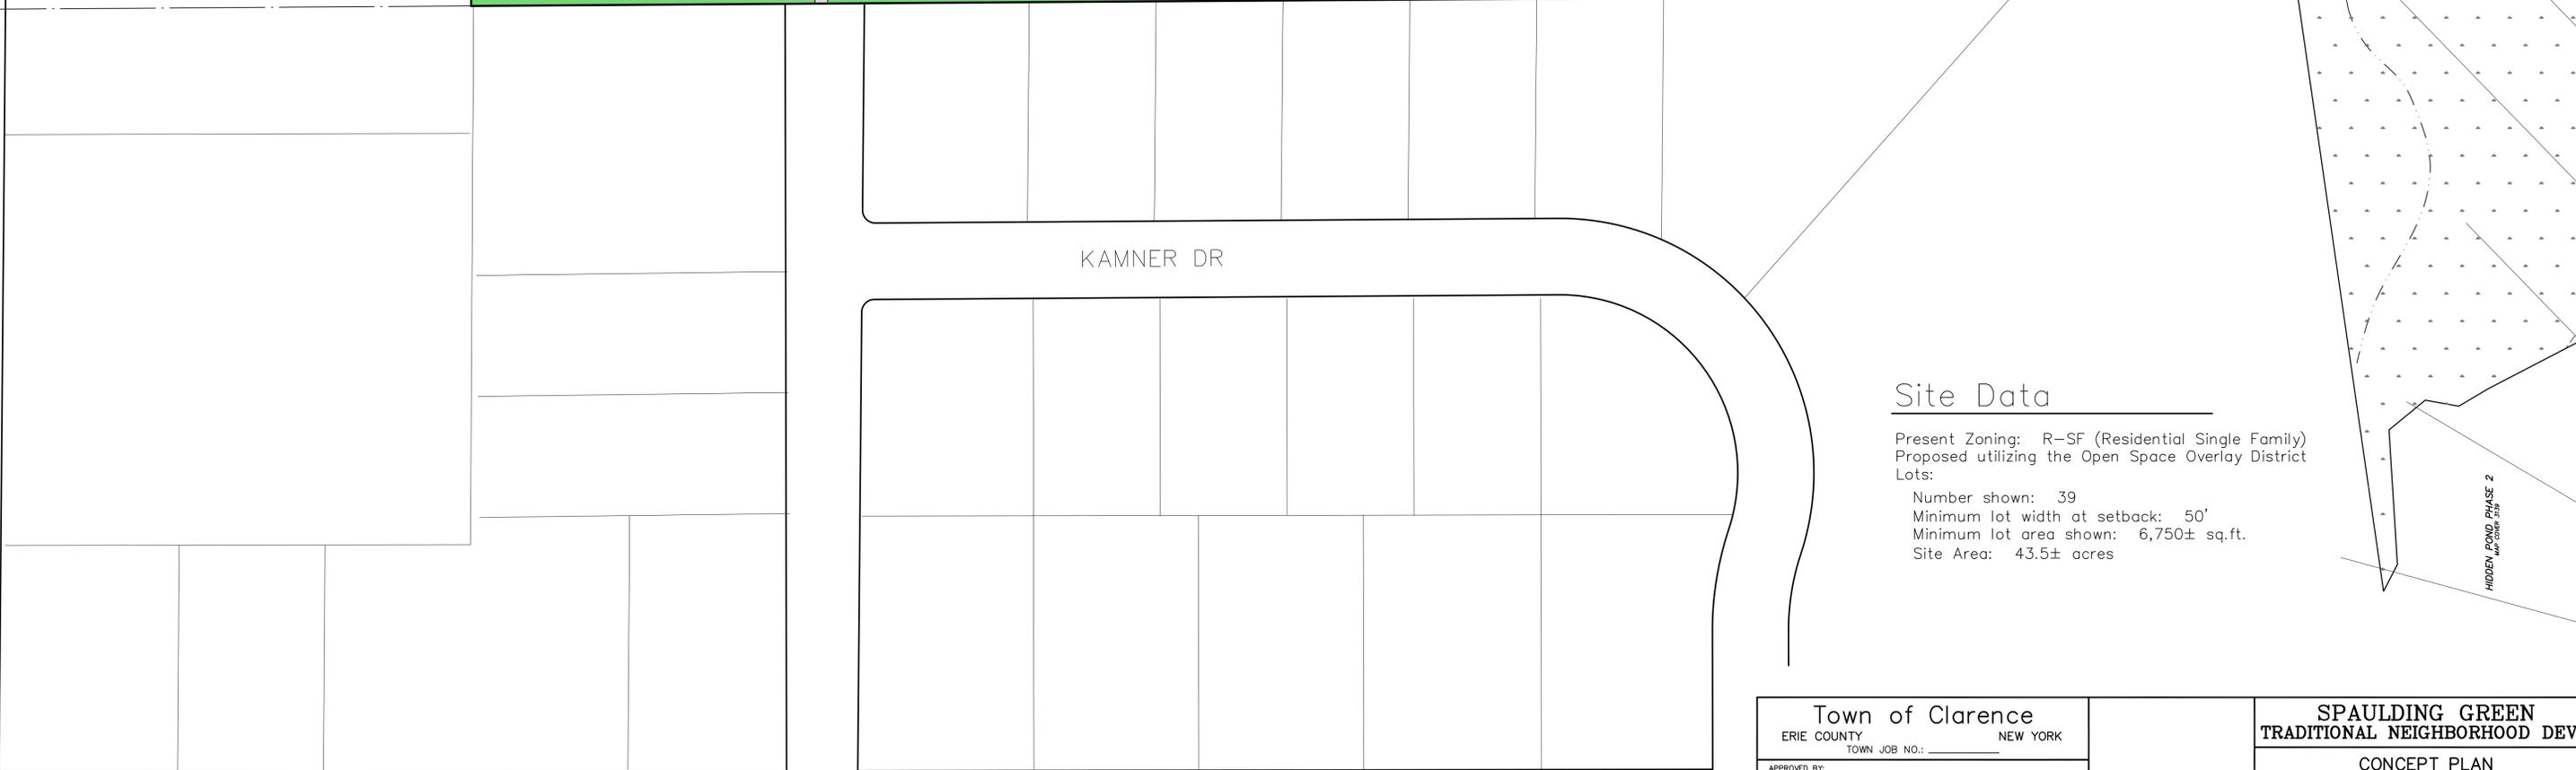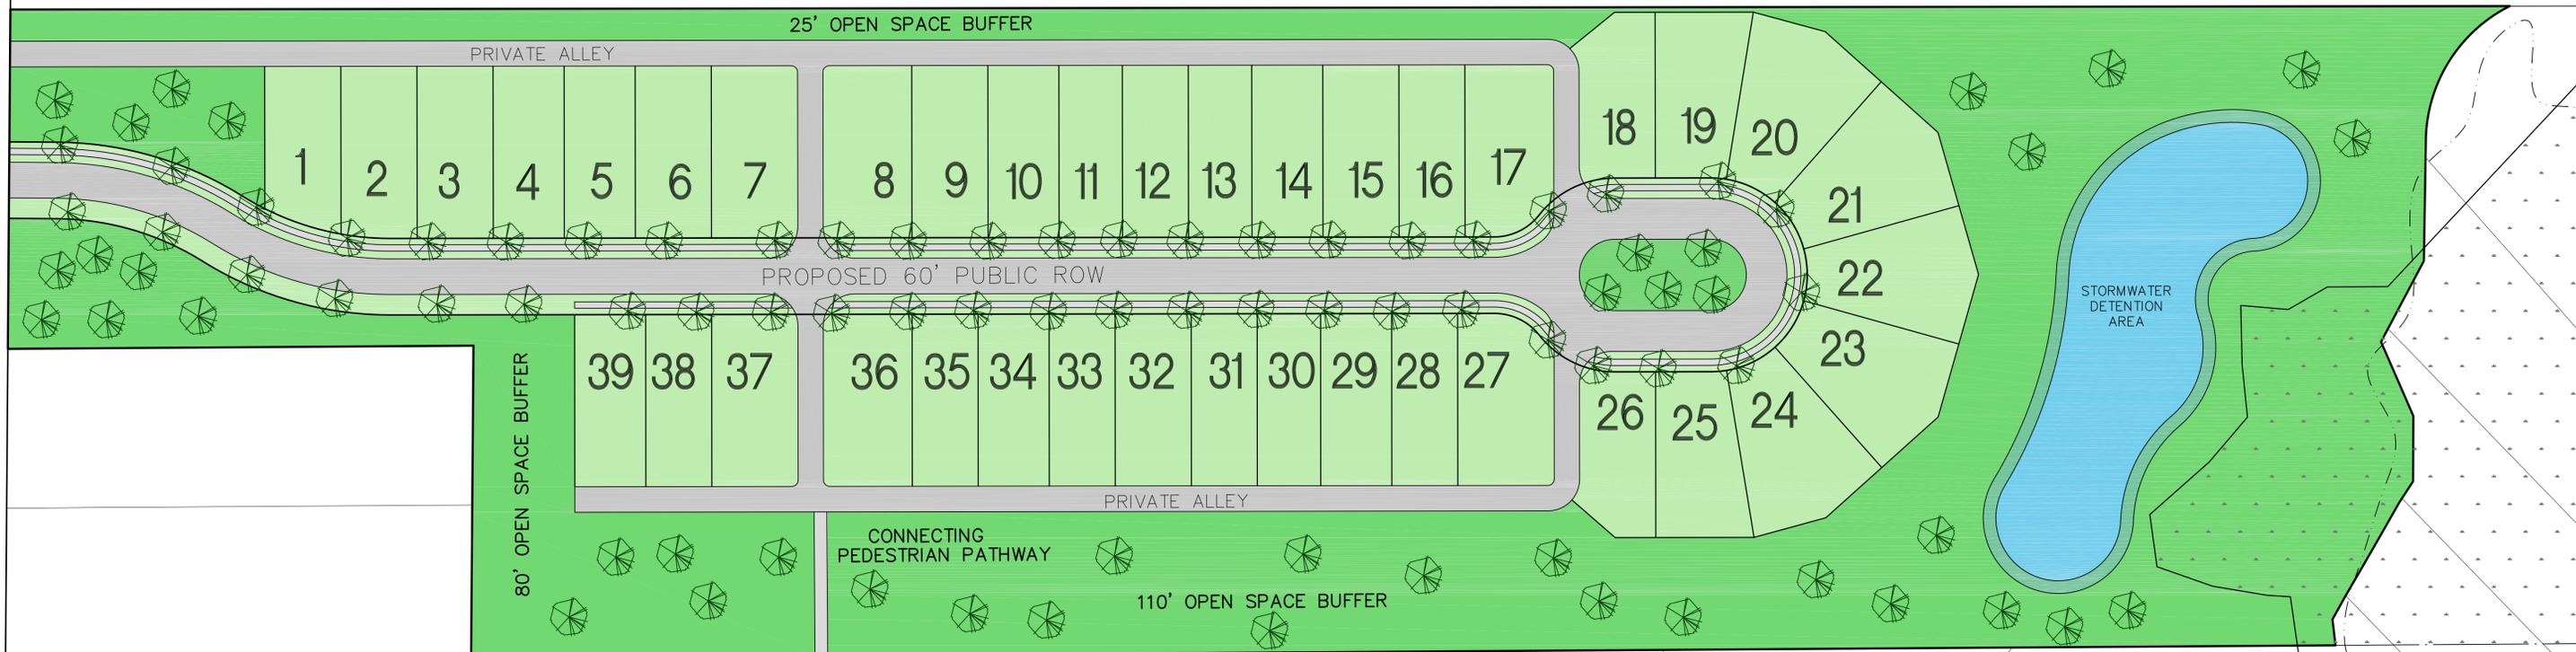

Site Data

Present Zoning: R-SF (Residential Single Family)  
 Proposed utilizing the Open Space Overlay District  
 Lots:  
 Number shown: 39  
 Minimum lot width at setback: 50'  
 Minimum lot area shown: 6,750± sq.ft.  
 Site Area: 43.5± acres

HIDDEN POND PHASE 2  
 1/2" = 100'

Town of Clarence  
 ERIE COUNTY NEW YORK  
 TOWN JOB NO.: \_\_\_\_\_

APPROVED BY: \_\_\_\_\_ DATE: \_\_\_\_\_

TOWN ENGINEER \_\_\_\_\_ DATE: \_\_\_\_\_

REVISION	DATE	BY
REVISED PLAN AS PER BOARD & RESIDENT COMMENT	5/09/12	KCZ

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**SPAULDING GREEN  
 TRADITIONAL NEIGHBORHOOD DEV.**

CONCEPT PLAN

**GPI** **GREENMAN-PEDERSEN, INC.**  
 CONSULTING ENGINEERS  
 ENGINEERING • SURVEYING • PLANNING  
 SURVEYING SERVICES PERFORMED BY OF ENGINEERING AND SURVEYING LLP  
 4950 GENESEE STREET SUITE 165 BUFFALO, NY 14225  
 (716) 833-4644 FAX (716) 833-4940

DRAWN: \_\_\_\_\_ JOB NO.: 2007086 SHEET NO.: \_\_\_\_\_  
 CHECKED: \_\_\_\_\_ DATE: APRIL 2012  
 1" = 60'

CREEKVIEW DR